GOODMAN BUILDING **30-32 E THIRD STREET BETHLEHEM, PA**

COLLABORATION 3 1 EAST BROAD STREET #310, BETHLEHEM, PA 18018

GENERAL CONDITIONS

- IN CASE OF CONFLICT BETWEEN NOTES, DETAILS, AND SPECIFICATIONS, THE MOST STRINGENT REQUIREMENTS SHALL GOVERN PERFORM ALL WORK INCLUDING CONSTRUCTION PRACTICES, USE AND DISPOSAL OF MATERIALS, AND QUALITIES F WORKMANSHIP, IN STRICT ACCORDANCE WITH THE REQUIREMENTS OF THE GOVERNING LOCAL, STATE, AND
- MEASURES SATISEYING ALL OSHA REQUIREMENTS QUALITY OF MATERIALS AND WORKMANSHIP SHALL BE IN A PRACTICES OF THE TRADES INVOLVED.
- HALL FILE ALL REQUIRED INSURANCE CERTIFICATES AND OBTAIN ALL PERMITS PRIOR TO COMMENCEMENT OF THE WORK, COSTS OF PERMITS TO BE PAID BY BUILDER, APPROVE RMIT TO BE POS
- DOCUMENTS, INCLUDING AN ORIGINAL STAMPED SET OF DRAWINGS AND A SUBSEQUENT CHANGES AND CLARIFICATIONS SHALL BE KEPT ON SITE AT ALL TIMES. ALL PROPOSED CHANGES TO ORIGINAL PROJECT DOCUMENT BID SET ARE TO BE SUBMITTED BY CONTRACTOR IN THE FORM OF CHANGE ORDERS, INCLUDING ALL BACKUP INFORMATION, FOR APPROVAL BY OWNER/ARCHITECT
- PRIOR TO COMMENCEMENT OF WORK, CONTRACTOR, OWNER, AND ARCHITECT TO HOLD A PRE-CONSTRUCTION CONFERENCE TO CONFIRM SITE ACCESS ROUTE, SCHEDULE, AND SEQUENCE OF WORK. THE CONTRACTOR SHALL BE RESPONSIBLE FOR THE SECURITY AND PROTECTION OF ALL CONDITIONS AND MATERIALS WITHIN THE PROPOSED CONSTRUCTION AREA. THE CONTRACTOR SHALL HAVE SOLE RESPONSIBILITY FOR ANY DAMAGE OR INJURY CAUSED BY OR DURING THE EXECUTION OF WORK.
- SECTIONS AND DETAILS SHOWN, WHILE DRAWN FOR SPECIFIC LOCATIONS, ARE INTENDED TO ESTABLISH THE GENERAL TYPES OF DETAILS TO BE USED THROUGHOUT. WORK NOT INDICATED ON A PART OF THE DRAWINGS BUT REASONABLY IMPLIED TO BE SIMILAR TO THAT SHOWN AT CORRESPONDING PLACES, SHALL BE REPEATED MINOR DETAILS NO USUALLY SHOWN OR SPECIFIED, BUT REQUIRED FOR PROPER CONSTRUCTION OF ANY PART OF THE WORK SHALL BE INCLUDED AS IF THEY WERE INDICATED IN THE DRAWINGS.
- CONTRACTOR TO VERIFY AND/OR ESTABLISH ALL EXISTING CONDITIONS AND DIMENSIONS AT THE SITE AND TO NOTIFY THE OWNER/ARCHITECT OF ANY DISCREPANCIES AND/OR DEVIATIONS FROM DRAWINGS. PROPOSED REMEDIES, IF REQUIRING ADDITIONAL WORK, ARE TO BE SUBMITTED FOR APPROVAL IN THE FORM OF WRITTEN CHANGE ORDERS TO THE OWNER IN ACCORDANCE WITH THE TERMS OF THE CONTRACT BEFORE ORDERING MATERIAL OR COMMENCING WITH WORK.
- CONTRACTOR TO VERIFY LOCATION OF ALL BELOW GRADE UTILITIES AND STORM WATER SYSTEMS PRIOR TO 10. EXCAVATION. NOTIFY ARCHITECT OF ANY CONFLICTS WITH PROPOSED CONSTRUCTION.
- ARCHITECT/ENGINEER IS NOT RESPONSIBLE FOR WORK THAT THE ARCHITECT/ENGINEER'S DOES NOT REVIEW 11. AND/OR WORK NOT COMPLETED IN ACCORDANCE WITH ARCHITECT/ENGINEER'S PLAN AND/OR INSTRUCTIONS. NO DEVIATION FROM DESIGN DRAWINGS IS PERMITTED WITHOUT WRITTEN APPROVAL. PROVIDE DAILY CLEAN-UP OF AREAS ADJACENT TO CONSTRUCTION AS WELL AS PERIODIC CLEAN-UP OF 12.
- CONSTRUCTION AREAS. AR JOB COMPLETION, BESIDES FINAL GENERAL CLEANING, REMOVE ALL STAINS AND PAINT FROM ALL NEW 13.

GLASS, TILE, AND OTHER FINISHES AND WASH AND POLISH STONE.

GENERAL DRAWING NOTES

GWB

- WRITTEN DIMENSIONS HAVE PRECEDENCE OVER SCALED DIMENSIONS. ITEMS NOT NOTED AS EXISITNG ARE NEW. DOORS AND WINDOWS NOT NUMBERED ON THE FLOOR PLAN OR
- ELEVATIONS ARE EXISTING TO REMAIN, UNLESS NOTED OTHERWISE. AL DIMENSIONS TO EXISTING SURFACES ARE TO FINISH, AND ALL DIMENSIONS TO NEW CONSTRUCTION ARE TO
- ROUGH FRAMING, UNLESS NOTED OTHERWISE. MECHANICAL, ELECTRICAL, & PLUMBING SYSTEMS INDICATED ON ARCHITECTURAL DRAWINGS FOR REFERENCE
- ONLY. COORDINATE WITH MEP DRAWINGS ENCLOSED ACCESSIBLE SPACE UNDER STAIRS SHALL HAVE WALLS AND SOFFITS PROTECTED BY 5/8" FIRE RATED

ABBREVIATIONS

ADJUST

AFF

APP

APPRO)

ARCHT

AWN

B/0

CBB

CL(🖗

CLG

CLR

CMU

COL

CONC

CONT

CPT

CSMT

DEMO

DBL

DED

DIM(S)

DWG(S)

DN

F.I

ELEC

ENG

EQ

EXG

EXP

EXT

FDN

FEC

FEN

FIN

FP

FTG

GΑ

GALV

GWB

HB

HC

HCAP

HDWD

HORIZ

HM

HOP

HTR

INCAN

INSUL

INT

FLR

FLUOR

СТ

CONTR

Adjacent

Adjustable Above Finish Floor Aluminum Access Panel Appliance Approximate Architect Awning Brick Course(s) Beadboard Bottom of Beam Basement Cementitious Backer Board Cabinet Cast Iron Control Joint Center Line Ceiling Clear Concrete Masonry Unit Column Concrete Continuous Contractor Carpet Casement Ceramic Tile Demolition Double Dedicated Drinking Fountain Double Hung Diameter Dimension(s) Down Drawing(s) Each Expansion Joint Electrical Engineered Equal, Equivalent Existing Expansion Exterior Floor Drain Foundation Fire Extinguisher Cabinet Fence Filter Fabric Finish Floor Fluorescent Fireplace Foot Footing Fixed Gauge Galvanized Gypsum Wallboard Hiah Hose Bib Hollow Core Handicap Hardwood Hollow Metal Horizontal Hopper Height Heater Incandescent Insulated Interior Joint



LIN
LKG LT
LT LV
LV LVL
MATL
MAX
MDO
MIN MFGR
MLDG
MO
MID
MTL
NA NIC
NTS
0/A
0/C
OPNG
OPP OPER
PL
PLAM
PLST
PLYWD
PNT(D)
PR PSL
PT
R
RAD
RAG RECP
recp Ref
REQD
RO
S&R
SAG
SC SCB
SCR SECT
SH
SIM
SL
SSTL
ST
STD STL
STN
STRUCT
Т
T&G
TBD
TE T/O
TYP
UNF
UNO
U/S
VCB
VCT VERT
VENT
VTR
W/
WD
WDW
WG WH
WH WP

WWF

Welded Wire Fabric

Low Linoleum Looking Light Low Voltage Laminated Veneer Lumber Material Maximum Medium Density Overlay Minimum Manufacturer Moulding Masonry Openin Mounted Metal Not Applicable Not In Contract Not To Scale Overall On Center Opening **Opposite Hand** Operable Plate Plastic Laminate Plaster Plywood Paint(ed) Pair Parallel Strand Lumber Pressure Treated Riser Radius Return Air Grill Receptacle Refrigerator Required Rough Opening Shelf And Rod Supply Air Grill Solid Core Screen Section Single Hung Similar Slider Stainless Steel Stucco Standard Steel Stone Structural Tread **Tongue and Groove** To Be Determined Tempered Top of Typical Unfinished Unless Noted Otherwise Underside Vinyl Cove Base Vinyl Composition Tile Vertical Verifv in Field Vent Thru Roof With Wood Window Wire Glass Water Heater Wall Paper

MATERIALS

GYPSUM WALLBOARD FOAM INSULATION BATT INSULATION BLOCKING BRICK CONCRETE CONCRETE MASONRY FINISH WOOD LAMINATED VENEER LUMBER (LVL) PARALLEL STRAND LUMBER (PSL) GRAVEL SHEATHING MD0/MDF RIGID INSULATION (SMALL SCALE) RIGID INSULATION (LARGE SCALE) ROUGH WOOD STEEL (LARGE SCALE)

SYMBOLS

A	WINDOW TYPE
ROOM	ROOM NAME/NO.
101	DOOR NUMBER
	EXTERIOR ELEVATION
1 A1	BUILDING/WALL SECTION CUT
	ENLARGED DETAIL
A1	
(1)	DETAIL
\oplus	EXG TOPOGRAPHIC ELEVATION
•	VERTICAL ELEVATION
$\hat{\Theta}$	INTERIOR ELEVATION
	REVISION
12 X	SLOPE

SHEET NUMBER	
GENERAL	
CS.01	COV
ARCHITECTURAL	
A0.01	DEN
A0.02	DEN
A1.01	BAS
A1.02	SEC
A1.03	FOU
A2.00	EXT
A3.00	BUI
A3.01	BUI
A3.02	BUI
A8.00	PEF
G0.01	WA
G0.02	ADA
G0.03	BUI
G0.04	BUI

LINE TYPES

	EXISTING WALL TO REMA
	ITEM TO BE DEMOLISHED
	WALL TO BE DEMOLISHED
	NEW WALL
	FUTURE WALL
	UPPER CABINETS
	HIDDEN ITEM
	ITEM ABOVE
	Center Line, Floor Line
0'-0"	DIMENSION
	MOISTURE / VAPOR BARF

FLASHING

 EXISTING WALL TO REMAIN
ITEM TO BE DEMOLISHED
 WALL TO BE DEMOLISHED
NEW WALL
 FUTURE WALL
 UPPER CABINETS
 HIDDEN ITEM
 ITEM ABOVE
 CENTER LINE, FLOOR LINE
 DIMENSION
 MOISTURE / VAPOR BARRIER

STONE PAVING

EARTH

STONE IN ELEVATION

GOODMAN BUILDING

30-32 E THIRD STREET Bethlehem, Pa

COLLABORATION 3

1 EAST BROAD STREET #310, BETHLEHEM, PA 18018

PROJECT TEA

ARCHITECT ALLOY5 ARCHITECTURE

	SUBMISSIONS
E DESCRIPTION	DATE

HISTORIC BOARD REVIEW 09/10/20

ISSU

SHEET NAME	SHEET ISSUE DATE	CURRENT REVISION	Current Revision Description
			•
/ERSHEET	09/10/2018		
10 PLANS	09/10/2018		
10 PLANS	09/10/2018		
EMENT/ FIRST FLOOR PLAN	09/10/2018		
OND/ THIRD FLOOR PLAN	09/10/2018		
RTH/ ROOF PLAN	09/10/2018		
ERIOR ELEVATIONS	09/10/2018		
LDING SECTIONS	09/10/2018		
DING SECTIONS	09/10/2018		
LDING SECTIONS	09/10/2018		
SPECTIVE VIEWS	09/10/2018		
LL PARTITION TYPES AND GENERAL NOTES	09/10/2018		
A GUIDELINES	09/10/2018		
LDING CODE ANALYSIS	09/10/2018		
LDING CODE ANALYSIS	09/10/2018		




COVERSHEE

DATE 09/10/2018 SCALE As indicated DRAWN BY CHECKED BY Checke JOB NO. 170021





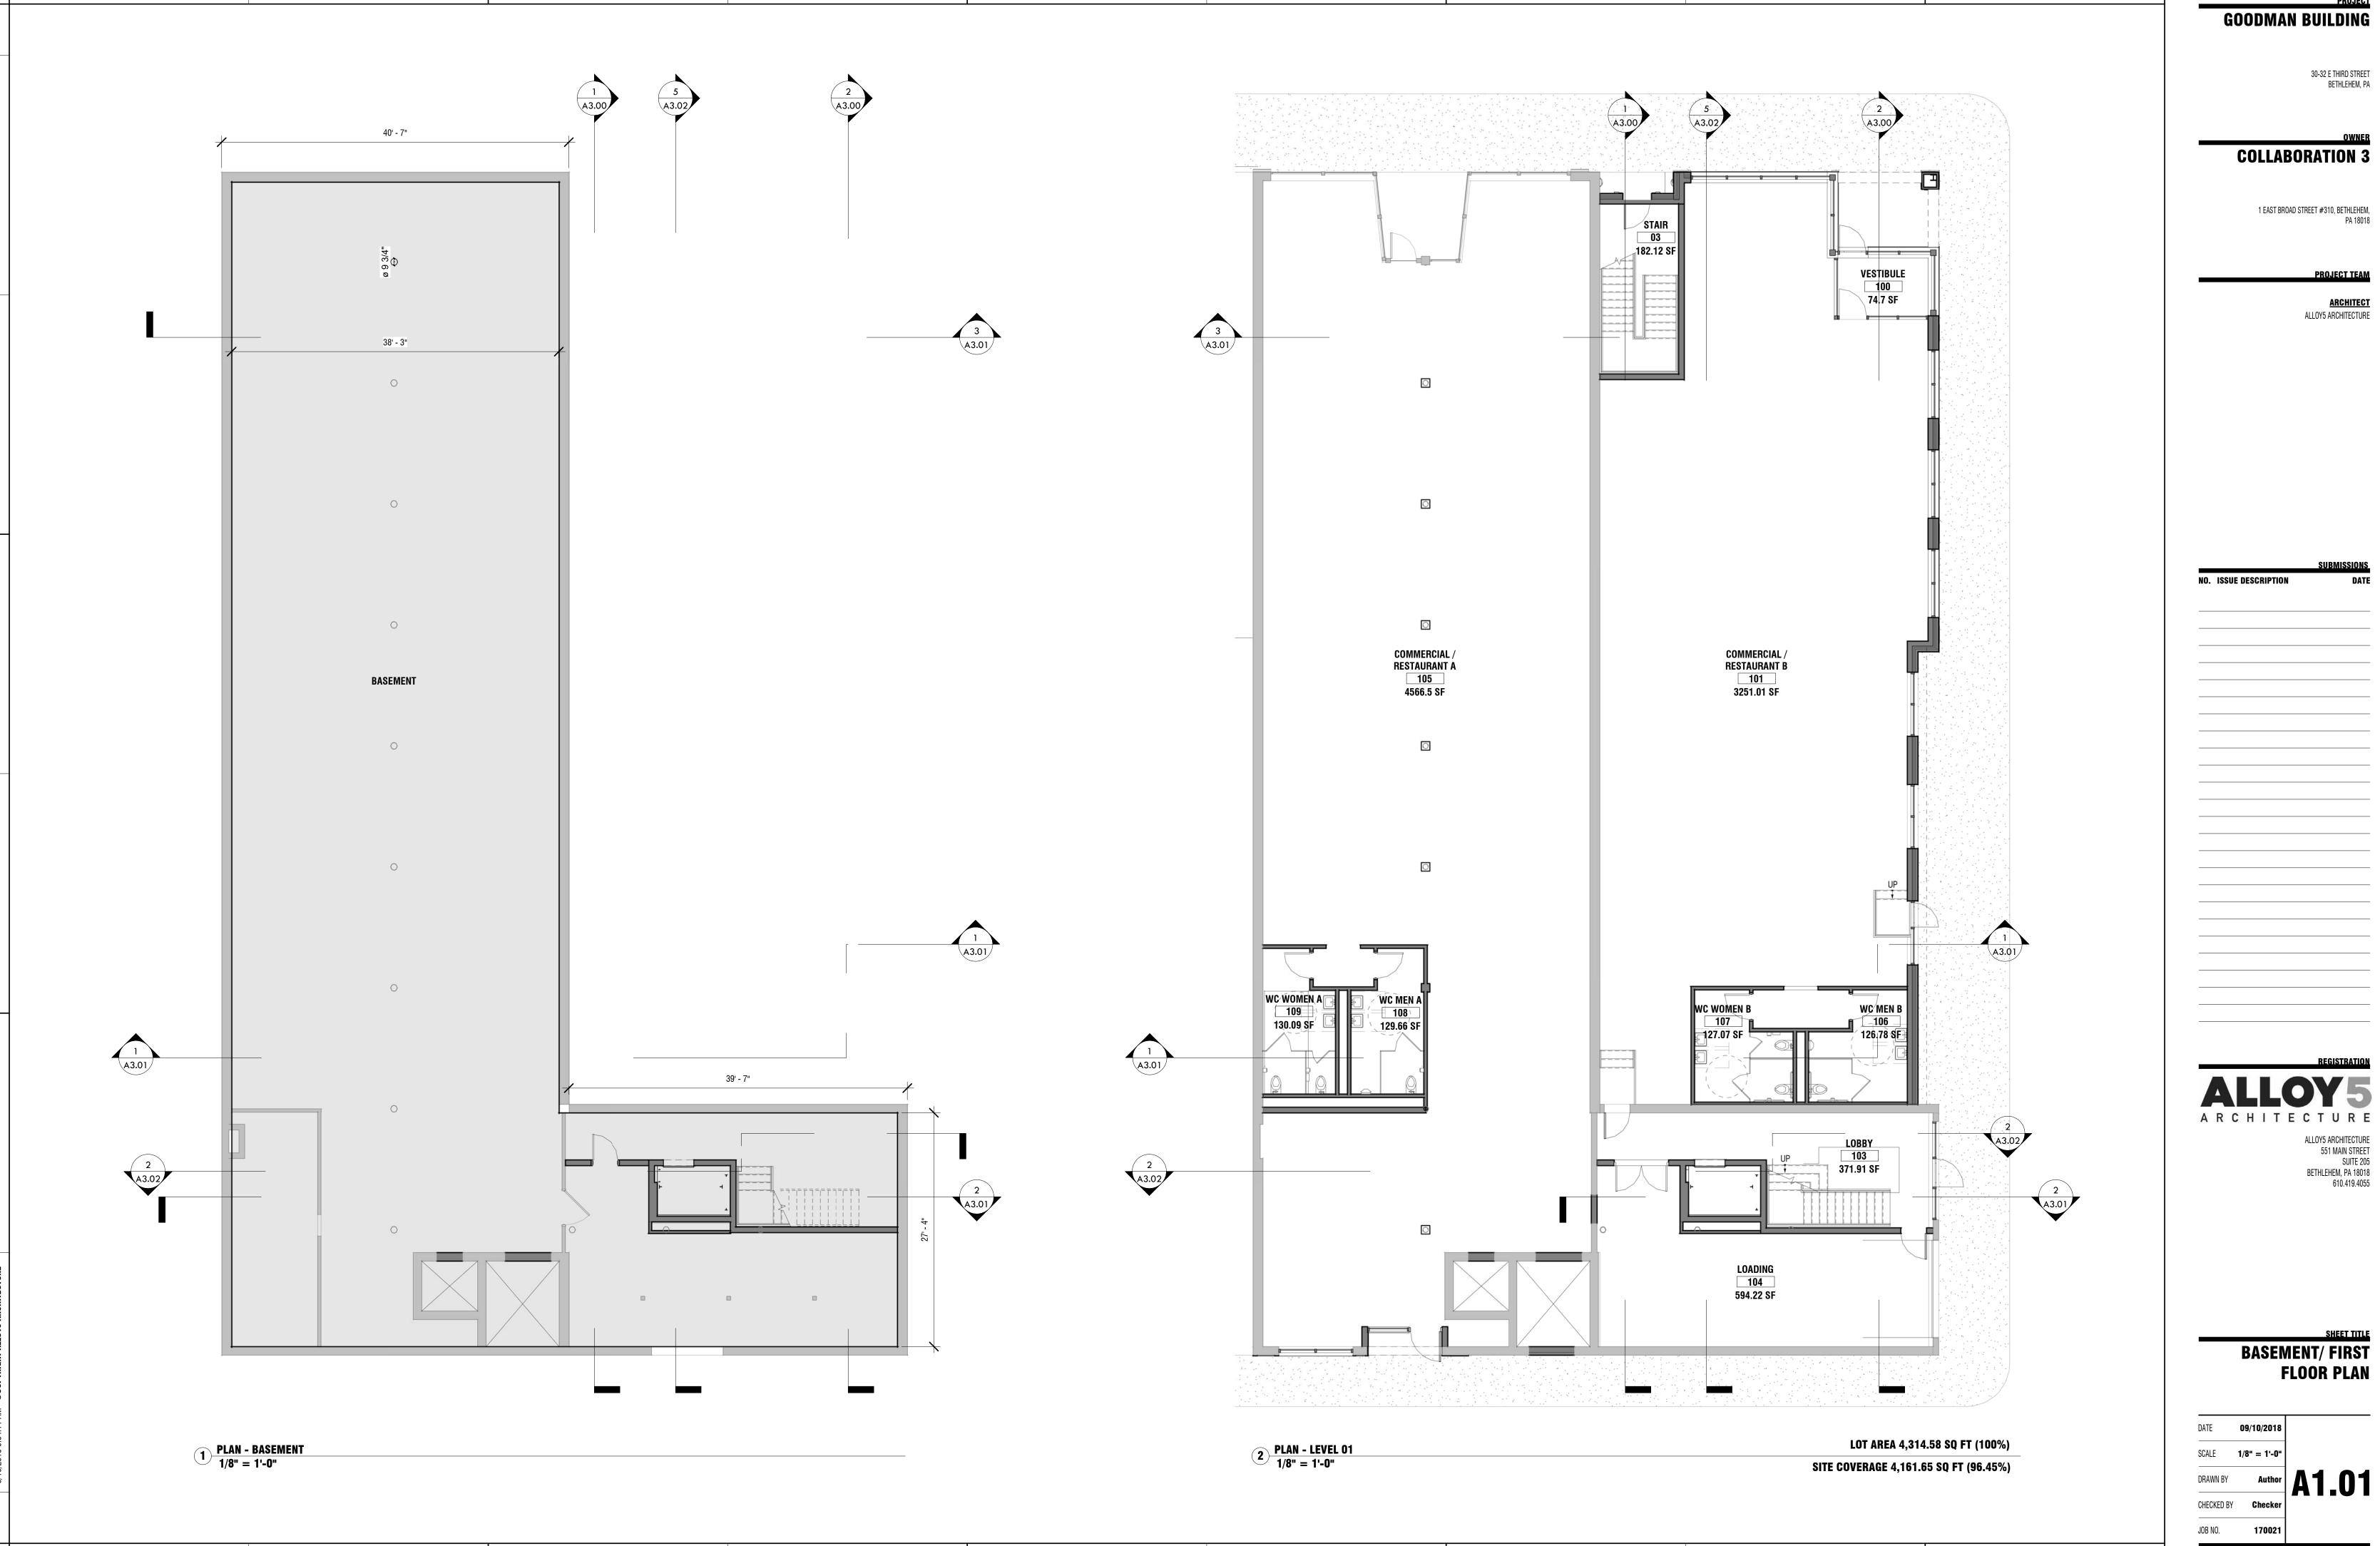



PROJECT GOODMAN BUILDING

30-32 E THIRD STREET BETHLEHEM, PA

COLLABORATION 3

1 EAST BROAD STREET #310, BETHLEHEM, PA 18018

PROJECT TEAN


ARCHITECT Alloy5 Architecture

SUBMISSIONS NO. ISSUE DESCRIPTION DATE

REGISTRATION **ALLOY5** ARCHITECTURE ALLOY5 ARCHITECTURE 551 MAIN STREET Suite 205 Bethlehem, pa 18018 610.419.4055

SHEET TITLE SECOND/ THIRD FLOOR PLAN

DATE **09/10/2018** SCALE **1/8" = 1'-0"** A1.02 DRAWN BY CHECKED BY Checke -----JOB NO. 170021

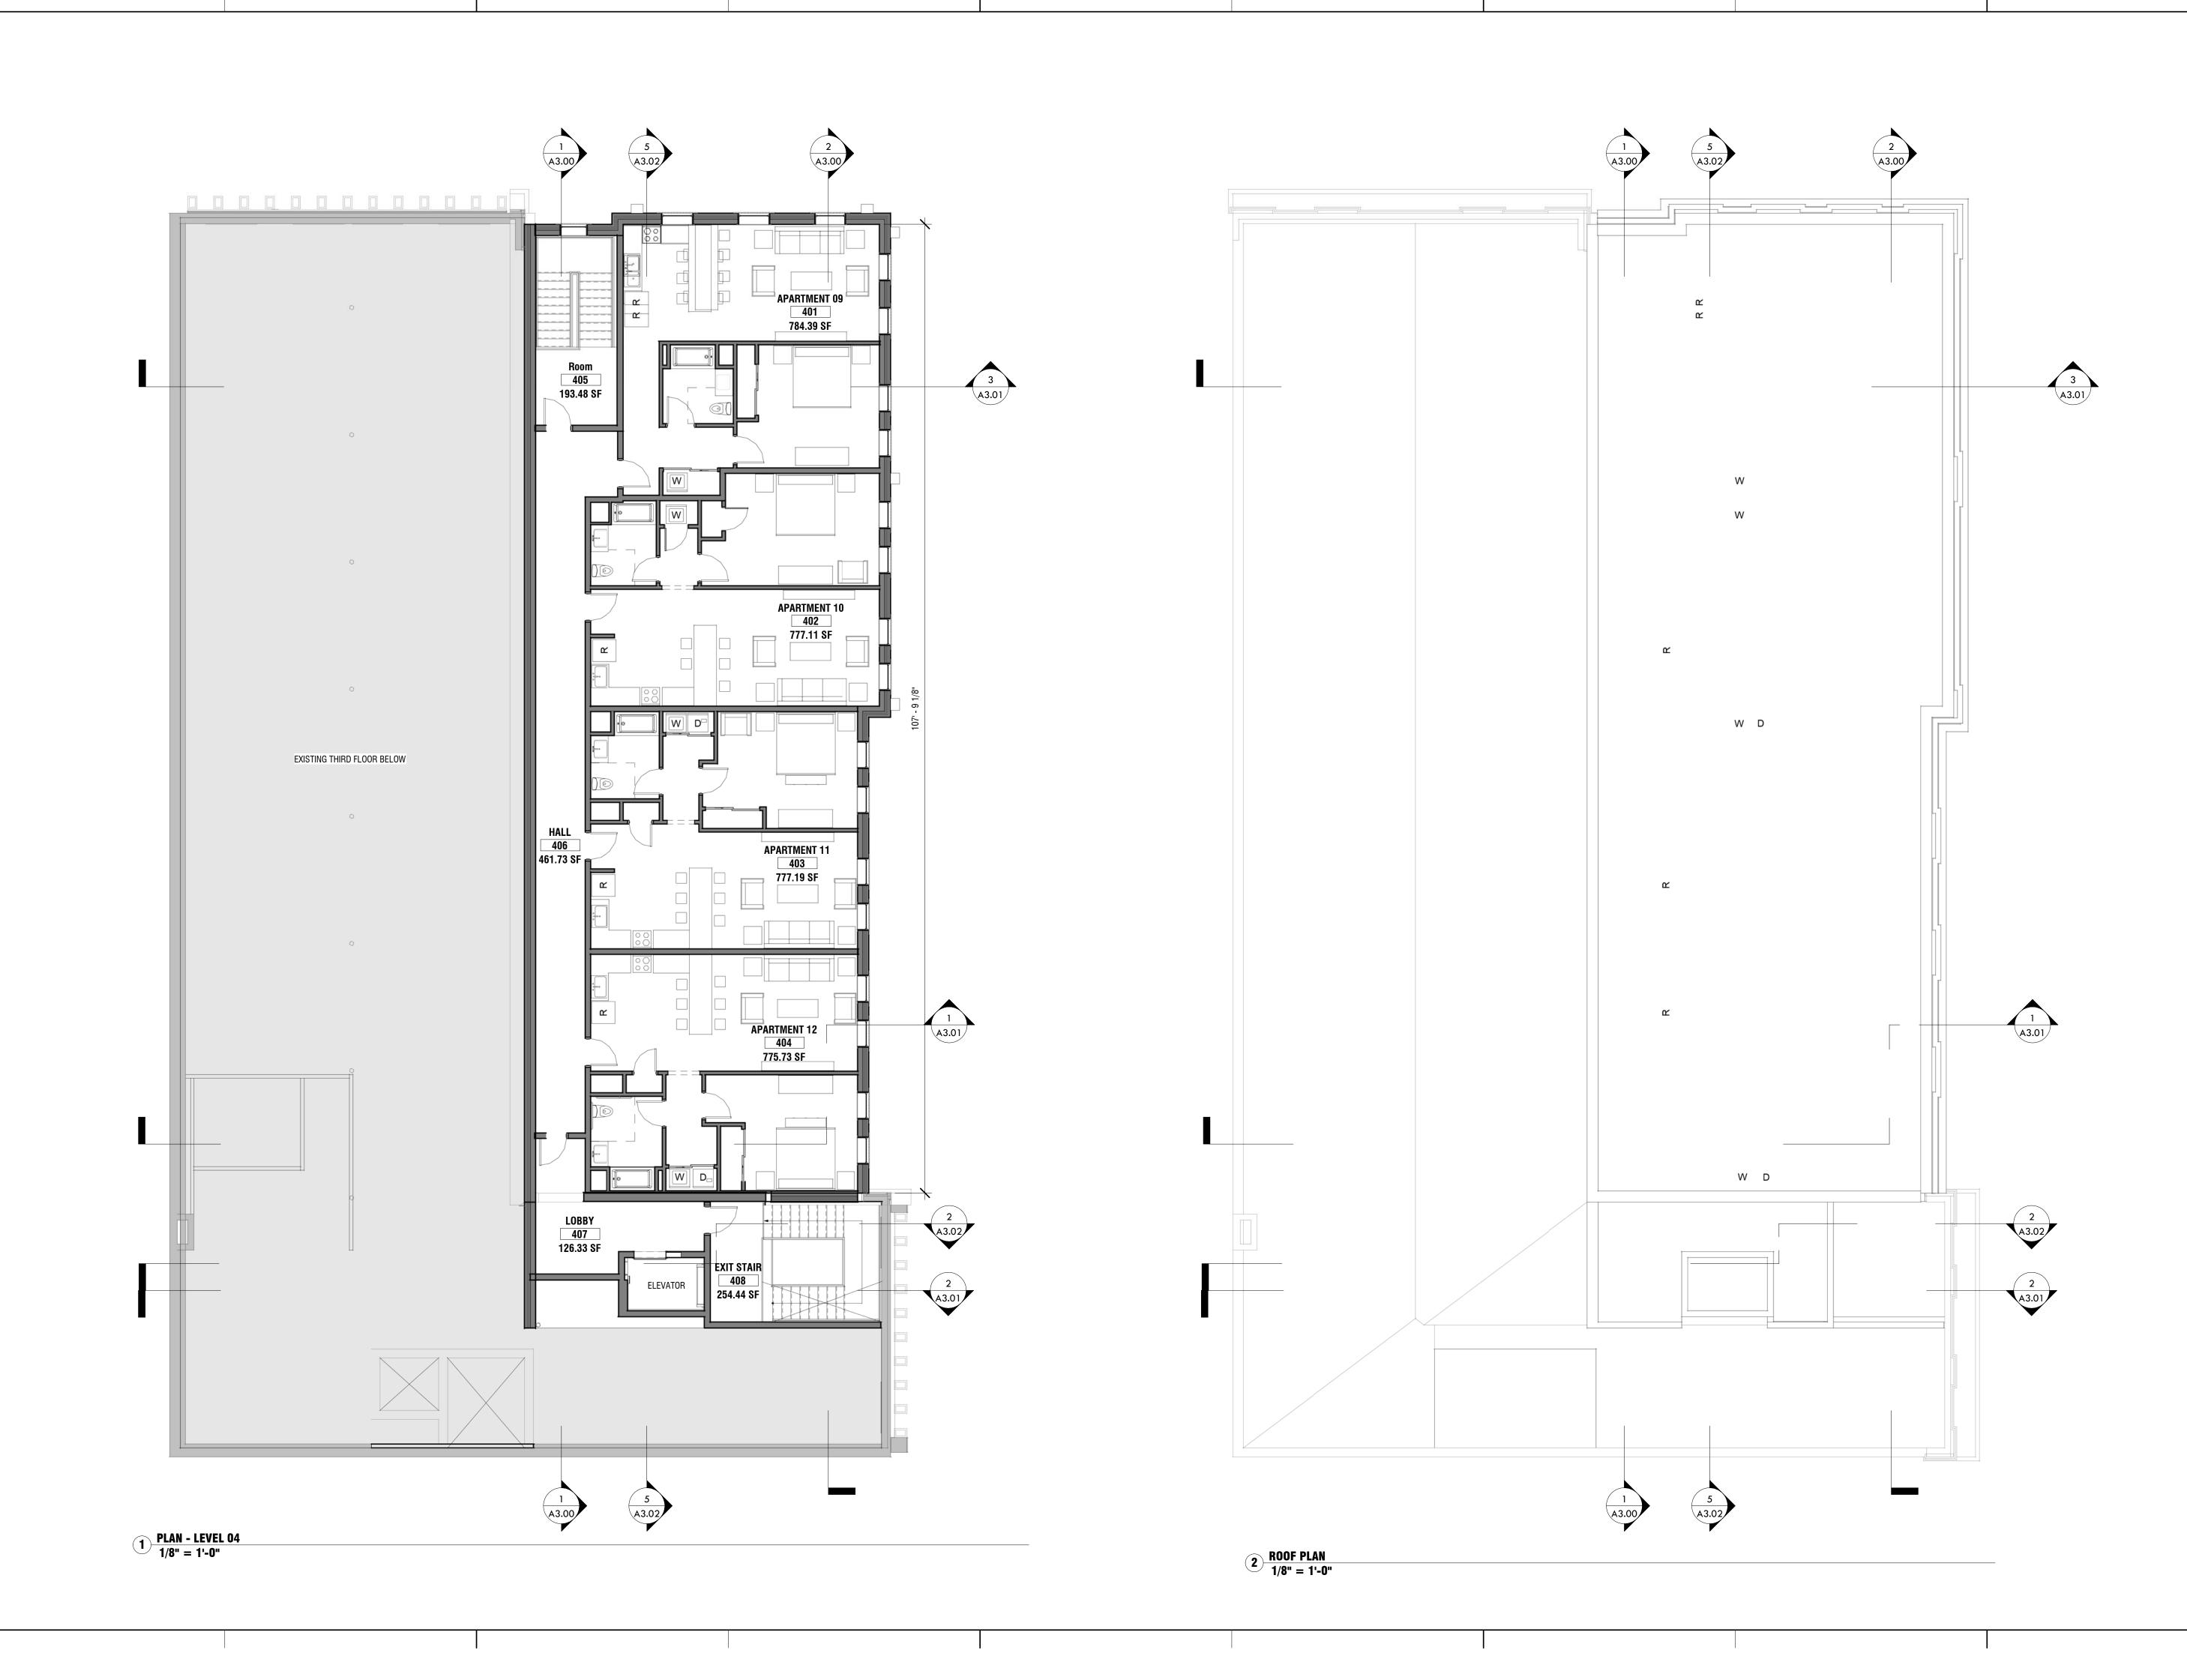

3/10/2018 9:54:20 AM ©COPYRIGHT ALLOY5 ARCHITECTI

GOODMAN BUILDING

30-32 E THIRD STREET BETHLEHEM, PA

COLLABORATION 3

1 EAST BROAD STREET #310, BETHLEHEM, PA 18018

PROJECT TEAM

ARCHITECT Alloy5 Architecture

SUBMISSION

DATE

NO. ISSUE DESCRIPTION

REGISTRATION ARCHITECTURE S51 MAIN STREET SUITE 205 BETHLEHEM, PA 18018 610.419.4055

SHEET TITLE FOURTH/ ROOF PLAN

 DATE
 09/10/2018

 SCALE
 1/8" = 1'-0"

 DRAWN BY
 Author

 CHECKED BY
 Checker

 JOB NO.
 170021





$1 \frac{\text{EAST ELEVATION}}{1/8" = 1'-0"}$

3 NORTH ELEVATION 1/8" = 1'-0"



GOODMAN BUILDING

30-32 E THIRD STREET BETHLEHEM, PA


COLLABORATION 3

1 EAST BROAD STREET #310, BETHLEHEM, PA 18018

PROJECT TEAM

ARCHITECT Alloy5 Architecture

SUBMISSIONS No. Issue description date

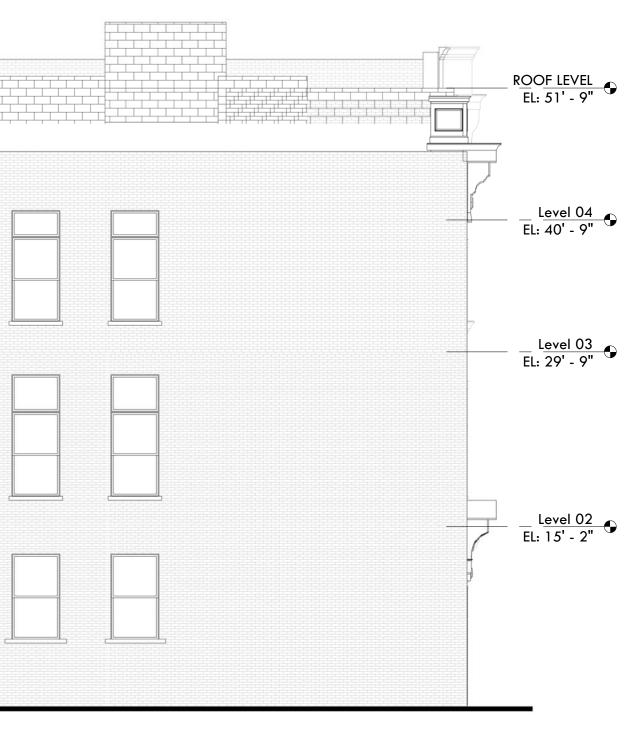

2 SOUTH ELEVATION 1/8" = 1'-0"



SHEET TITLE EXTERIOR ELEVATIONS

